STRUCTURAL NOTES

IMPORTANT PLEASE READ:

CURRENT LOCAL BUILDING CODES.

ALL CONSTRUCTION FROM THIS PLAN MUST CONFORM TO

WRITTEN DIMENSIONS ALWAYS TAKE PRECEDENCE OVER

THESE PLANS ARE NOT FOR RESALE. ANY REPRODUCTION OF THESE PLANS MUST HAVE THE WRITTEN CONSENT OF JM DESIGNS LLC

- 1. DESIGN LIVE LOADS (L.L.): FLOOR 40 P.S.F. & DEAD LOADS (D.L.) 15 P.S.F. ROOF L.L. SHALL BE BASED ON STRUCTURE LOCATION WITH NOMINAL L.L. OF 30 P.S.F.
- LUMBER: ALL WORK SHALL BE DONE IN STRICT ACCORDANCE WITH ALL APPLICABLE CODES AND IN CONFORMANCE WITH THE ST TRADE PRACTICES.
- 3. ALL STRUCTURAL LUMBER SHALL HAVE A MINIMUM BENDING STRESS OF 1200-Fb \pm 1.6 \times 10 TO THE 6TH P.S.I.
- ALL LUMBER IN CONTACT WITH MASONRY OR CONCRETE SHALL BE REDWOOD OR PRESSURE TREATED. ALL LUMBER SHALL BE FASTENED AND SEALED IN ACCORDANCE WITH ALL APPLICABLE CODES.
- 5. ALL LUMBER SHALL BE 545 WITH A MOISTURE CONTENT NOT TO EXCEED 15%.
- FOLLOW NAILING AND FASTENING SCHEDULES ACCORDING TO THE CURRENT IRC.
- DOUBLE ALL STUDS, RAFTERS AND JOISTS AROUND ALL OPENINGS, AND PROVIDE DOUBLE HEADERS ABOVE ALL WINDOW, STAIR AND DOOR NINGS. REFER TO LINTEL SCHEDULE BELOW.
- ${\tt USE\ JOIST\ HANGERS\ AND\ FRAMING\ CONNECTORS\ WHERE\ SHOWN\ IN\ THE\ DRAWINGS\ AND\ IOR\ WHERE\ REQUIRED\ TO\ INSURE\ A\ PROPER}$
- ALL LUMBER FOR FRAMING SHALL BE DOUGLAS FIR-LARCH, HEMLOCK, SPRUCE-PINE-FIR OR SOUTHERN PINE WITH A COMMERCIAL GRADE OF #2 OR BETTER & A MINIMUM BENDING STRESS AS LISTED ABOVE.
- 11. PROVIDE CROSS-BRACING AT MID-SPAN AND UNDER PARTITIONS RUNNING PERPENDICULAR TO JOISTS.
- 12. PREFABRICATED WOOD TRUSSES SHALL BE DESIGNED BY THE MANUFACTURER FOR THE SPANS AND CONDITIONS SHOWN ON THE PLANS.
- 13 WOOD TRUSGES SHALL LITTLIZE APPROVED CONNECTOR PLATES (GANGRALL OR EQUAL) FURNISH SHOP DRAWINGS AND DESIGN CALCULATIONS 13. YADDI TRUSSES SHALL DI ILIZE AFFOVED CONNECTOR FLATES (GANGKALL ON EXDAL), FURNISH SHOP DRAYINGS AND DESIGN CALCULATION (COMPLETE WITH 5TRESS) BLOCKANS) FOR A REGISTERED PROFESSIONAL ENGINEER, PROVIDE FOR SHAPES, BEARING FOINTS, HIP FRAMING, ETC. SHOWN ON THE DRAYINGS. PROVIDE FOR ALL TEMPORARY AND PERMANENT TRUSS BRACING AND BRIDGING. TRUSS SHALL CARRY MANUFACTURERS STAMP. CONTRACT SHALL HAVE DESIGN DETAILS AND DRAVINGS ON SITE FOR FRAME INSPECTION. NO TRUSS SHALL BE FIELD MODIFIED WITHOUT PRIOR APPROVAL OF THE TRUSS ENGINEER.
- OP PLATES SHALL BE DOUBLED ON ALL STUD WALLS. CRIPPLES UNDER HEADERS SHALL BE CONTINUOUS TO SOLE PLATE. BLOCK ALL STUD WALLS AS REQUIRED FOR SHEATHING. BLOCKING (2" WIDE OF EQUAL DEPTH OF THE MEMBERS) SHALL BE PROVIDED BETWEEN ALL JOISTS AND RAFTERS AND THEIR SUPPORT UNLESS MEMBERS ARE NAILED TO RIM JOIST.
- 15. BEAMS, GIRDERS, AND JOISTS SUPPORTING BEARING WALLS OR OTHER CONCENTRATED LOADS SHALL NOT BE NOTCHED. JOISTS EXCEPT AS ABOVE MAY BE NOTCHED NO DEEPER THAN 14 THE DEPTH, AT TOP EDGE ONLY, PROVIDED SUCH NOTCH IS LOCATED NATHIN 18 TO 14 OF SPAN FROM FACE OF SUPPORT. SAY CUTS FOR NOTCHES SHALL NOT OVERRUN DEPTH OF NOTCH. HOLES IN JOISTS, BEAMS, AND GIRDERS SHALL NOT BE LARGER IN DAMETER THAN 1/10 THE DEPTH OF NEMBER AND SHALL BE LOCATED WITHIN CENTER HALF OF THE SPAN, ALL HOLES SHALL BE CENTERED WITHIN DEPTH OF MEMBER HOLES AND NOTCHES IN STUDS SHALL BE LOCATED WITHIN 18 OF HEIGHT FROM EITHER TOP OR BOTTOM BUT NO CLOSER THAN 8" FROM PLATES. HOLES AND NOTCHES IN STUDS SHALL NOT EXCEED 1" IN DIAMETER OR DEPTH. STUDS IN EXTERIOR WALLS SHALL
- 16. JOISTS, RAFTERS, HEADERS, AND DECKING SHALL NOT BE CUT OR SPACED TO PROVIDE FOR OPENINGS IN ROOFS OR FLOORS, EXCEPT AS DETAILED ON DRAWINGS. INSTALL ALL HORIZONTAL MEMBERS WITH CROWN UP. ALL MEMBERS IN BEARING SHALL BE ACCUPATELY OUT AND ALIGNED SO THAT FULL BEARING IS PEARING SON OF SUPPORT UNDER ALL RAFTERS SHALL BE AND ALL BEARING OF THE PROPERT UNDER ALL RAFTERS SHALL BE ROTCHED FOR FULL BEARING AT ALL SUPPORTS. ALL JOISTS SHALL HAVE A MINIMUM OF 1 1/2" BEARING ON WOOD OR METAL SUPPORTS.
- 17. LEDGERS AND STUD WALL FOUNDATION SILL PLATES SHALL BE BOLTED TO CONCRETE WITH ANCHOR BOLTS OF SIZE AND MINIMUM SPACING AS SHOWN ON DRAWINGS, AT LEAST TWO BOLTS SHALL BE PROVIDED FOR EACH PIECE WITH ONE BOLT WITHIN 12" OF EACH END.
- 18. ALL FLYYOOD WALL SHEATHING SHALL BE APPLIED AS FOLLOWS: CENTER VERTICAL JOINTS OVER STUDS AND CENTER HORIZONTAL JOINTS OVER STUDS AND CENTER HORIZONTAL JOINTS OVER STUDS AND CENTER HORIZONTAL JOINTS OVER STUDS AND FAIRED STUD ANCHORED SILL PLATE. APPLY GYPSUM BOARDS SO THAT END JOINTS OF ADJACENT COURSES DO NOT OCCUR OVER THE SAME STUD.
- 20 SOIL VALUE: SOIL BEARING VALUE IS ASSUMED TO BE 2000 psf. THE CONTRACTOR SHALL NOTIFY THE ARCHITECT 3 DAYS PRIOR TO PLACING INGS. THE CONTRACTOR SHALL BE RESPONSIBLE FOR NOTIFICATION OF ALL REVIEW AGENCIES FOR THEIR INSPECTION AT ALL
- 21. CONCRETE: ALL CONCRETE SHALL BE 3000 P.S.I. AIR ENTRAINED CONCRETE WITH THIS STRENGTH BEING REACHED IN 25 DAYS, CAREFULLY CURE AND PROTECT BOTH FOOTING AND SLAB CONCRETE FROM RAPID DRYING. COVER SLAB CONCRETE TO ENGURE PROPER DRYING.
- 22. SLABS ON GRADE: UNLESS OTHERWISE NOTED ON DRAWINGS, SLABS ON GRADE SHALL BE 4" THICK PROTER DATING.

 NOTH 666 WILLIAM LAVELUED MIRE FARRIC. PLACING, LAP, ETC., SHALL COMPORM TO MIR STANDARDS. FILLING UNDER SLABS ON GRADE SHALL BE
 MADE WITH MATERIAL APPROVED BY THE ARCHITECT AND SHALL BE COMPACTED IN A MANNER THAT WILL NOT DAMAGE FOUNDATION WALLS. IT
 SHOULD BE WILL TAMPED IN 6" LAYERS IN ROUGH THICKNESS, TO 49% MAXIMUM DRY DENSITY PER ASTM D-6%. CONCRETE SHALL BE PLACED OVER
 4" MINIMUM COURSE GRAVEL BASE.
- 23. BACKFILL COMPACTION: THE CONTRACTOR SHALL TAKE ALL NECESSARY PRECAUTIONS TO BRACE FOUNDATION WALLS WHEN BACKFILLING. BACKFILLING AGAINST SUCH WALLS SHALL BE DONE IN A MANNER THAT WILL NOT DAMAGE WALLS BUT SHOULD BE WELL TAMPED IN 8" LAYERS IN ROUGH THICKNESS TO 95% MAXIMUM DRY DEPOIT, ALL PRECAUTIONS SHOULD BE TAKEN FOR ADEQUATE DRAINAGE PRIOR TO AND AFTER SUCH BACKFILLING TO ENSURE WATER RUN-OFF AWAY FROM THE BUILDING.
- FOOTINGS: BOTTOMS OF ALL FOOTINGS SHALL EXTEND 11-0" MINIMUM INTO UNDISTURBED SOIL AND A MINIMUM 36" BELOW FINISHED GRADI SHALL BE EXTENDED BELOW ELEVATIONS SHOWN WHERE NECESSARY TO REACH THE ABOVE SOIL BEARING VALUE. CONCRETE SLAB TINGS SHALL BE TREND NOT LESS THAN
- 25. REINFORCING STEEL: REINFORCING STEEL SHALL BE NEM BILLET DEFORMED BARS, ACCURATELY PLACED AND ADEQUATELY SUPPORTED BY CONCRETE, METAL, OR OTHER APPROVED CHAIRS, SPACERS, OR TIES AND SECURED AGAINST DISPLACEMENT DURING CONCRETE PLACEMENT. TACK MELDING NOT ALLOWED EXCEPT WHERE SHOWN.

- <u>GENERAL NOTES.</u>

 1. THE CONTRACTOR SHALL BE RESPONSIBLE FOR VERIFYING THE FIELD MEASUREMENTS PRIOR TO ORDERING MATERIALS & PREFABRICATING ITEMS.
 ANY NECESSARY ADJUSTMENTS IN FIELD DRAWINGS SHALL BE MADE IN ACCORDANCE WITH THE DECISION OF THE ARCHITECT.
- 2. CONTRACTOR SHALL PROVIDE BACKING/BLOCKING AS REQUIRED FOR ALL WALL MOUNTED EQUIPMENT, FURNISHINGS, ETC.
- 3. ALL PARTITION DIMENSIONS ARE TO FACE OF FRAMING OR TO CENTERLINE OF PARTITIONS, STRUCTURAL COLUMNS, AND BEAMS U.N.O.
- 4. ALL COMBUSTIBLE MATERIALS TO BE A MINIMUM OF 1" CLEAR OF ALL HEAT TRANSFERRING VENT STACKS.
- 5. BE A MINIMUM OF 1" CLEAR OF ALL HEAT TRANSFERRING VENT STACKS.
- STAIRWAYS: MEET CURRENT IRC R311.5. MINIMUM HEADROOM 6'8", MINIMUM WIDTH 36", HANDRAIL TO HAVE ENDS RETURNED AND PLACED MINIMUM 34" AND MAXIMUM 30" ABOVE TREAD NOSING. THE HANDGRIP FORTION OF HANDRAIL SHALL NOT BELLESS THAN 1 1/2" NOR MORE THAN 2" IN CROSS SECTION DIMENSION. HANDRAIL PROJECTING FROM A WALL SHALL HAVE A SPACE OF NOT LESS THAN 1 1/2" NOR MORE THAN 2" IN CROSS SECTION DIMENSION. HANDRAIL PROJECTING FROM A WALL SHALL HAVE A SPACE OF NOT LESS THAN 1 1/2" PETWEEN THE WALL AND THE HANDRAIL. INSTALL FIRE ELOCKING AT TOP AND POTTOM OF STAR RUN. DISEABLE SPACE UNDER STANE TO BE SUPREMITH 50" TYPE ""C STYP BD., TAPED 8 FINISHED ONE HOUR CONSTRUCTION. ALL GUARDRAILS TO MEET IRC STANDARDS. MIN. 3" TALL WI NO OPENING LARGER THAN 4".
- REGARDLESS OF OCCUPANT LOAD, THERE SHALL BE A FLOOR OR LANDING ON EACH SIDE OF DOOR WHEN ACCESS FOR PHYSICALLY HANDICAPPED IS REQUIRED SEE: INC. 8311.43, THE FLOOR OR LANDING SHALL BE NOT MORE THAN 1/2" LOVIER THAN THE THRESHOLD OF THE DOORWAY. WHEN SUCH ACCESS IN NOT REQUIRED, SUCH DINNERSION SHALL NOT EXCEED 1".
- 8. EXITS SHALL BE ILLUMINATED AT ANY TIME THE BUILDING IS OCCUPIED WITH LIGHT OF NOT LESS INTENSITY THAN 1 FOOTGANDLE AT FLOOR LEVEL
- ATTIC VENTILATION: THE NET FREE VENTILATING AREA SHALL BE NOT LESS THAN 1/150 OF THE AREA OF THE SPACE VENTILATED, EXCEPT THAT THE AREA MAY BE 1/300, PROVIDED AT LEAST 50% OF THE REQUIRED VENTILATING AREA IS PROVIDED BY VENTILATOR LOCATED IN THE UPPER PORTION OF THE SPACE TO BE VENTILATED AT LEAST 3 ABOVE EAVES OR CORNIC'S VENTS WITH THE BALANCE OF THE REQUIRED VENTILATION PROVIDED BY EAVES OR CORNICE VENTS. RAFTER SPACES ENCLOSED BY CEILINGS DIRECTLY APPLIED TO UNDERSIDE OF RAFTERS SHALL BE SIZED TO A LLOVIA MINIMUM I' CLEAR VENTED AIR SPACE ABOVE THE INSULATION. ATTICS WITH A MAXIMUM CLEAR HEIGHT OF LESS THAN 30" NEED NOT BE PROVIDED WITH ACCESS
- 10. APPROVED FLASHING TO BE INSTALLED AT ALL CHIMNEYS, WALL-TO-ROOF INTERSECTIONS, AROUND ALL ROOF PENETRATIONS AND ABOVE ALL EXTERIOR DOOR AND ININDOVIOPENINGS.
- 11. EXTERIOR JOINTS AROUND WINDOWS AND DOOR FRAMES, OPENINGS BETWEEN WALLS AND FOUNDATIONS, BETWEEN WALLS AND ROOF, AND BETWEEN WALLS AND PANELS, OPENINGS AT PENETRATIONS OF UTILITY SERVICES THROUGH WALLS, FLOORS, AND ROOFS, AND ALL OTHER SUCH OPENINGS IN THE BUILDING ENVELOPE, INCLUDING ACCESS PANELS INTO HEATED SPACES SHALL BE SELEC, CALLED, CALVED, CASCETED, OR WEATHER STRIPPED TO LIMIT AIR LEAKAGE, ALL EXTERIOR DOORS, OTHER THAN FIRE-RATED DOORS, SHALL BE DEED TO LIMIT AIR LEAKAGE AROUND THEIR
- 12 PROVIDE GYPSUM WALL BOARD OF THE TYPE AND THICKNESS INDICATED ON DRAWINGS, GYPSUM BOARD WORK AND MATERIALS SHALL MEET ALL REQUIREMENTS OF ANSI NO. A 91-1 FOR THE "APPLICATION AND FINISHING OF PWALLBOARD" JOINT COMPOUND SYSTEM MIXED, APPLIED, AND FINISHED IN COMPLIANCE WORTH MANUFACTURERS PRINTED DIRECTIONS, TO SE INVISIBLE AFTER PRINSHED, INCLUDING ALL TAL CORNER BEADS AND TRIM.
- 13 COVER SURFACES BEHIND SHINGLES AND WHERE INDICATED ON DRAWINGS WITH ASPHALT SATURATED NON-PERFORATED FELT WITHOUT WRINKLES OR BUCKLES. LAP HORIZONTAL JOINTS 3", 6" AT VERTICAL JOINTS AND CARRY INTO OPG'S

BALD EAGLE LAND INC. (PLAN 401.1) 210 KARNEL CT. EAST HELENA, MT. 59635

| SHEET INDEX | |
|----------------------|------|
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STRUCTURE DATA

3 BEDROOM 2 BATH

FINISHED LIVING SPACE 2 CAR GARAGE

= 1.697 SF

PLANS PREPARED FOR: BALD EAGLE LAND INC. 406-439-0669



- 1. ALL EXTERIOR DIMENSIONS ARE TO THE MAIN LAYER. DIMENSIONS TO OPENINGS ARE TO THE FRAMING, ROUGH OPENING. INTERIOR DIMENSIONS ARE TO THE FINISHED WALL.
- 2. CONTRACTOR SHALL VERIFY ALL DIMENSIONS AND IS RESPONSIBLE FOR ALL DIMENSIONS (INCLUDING ROUGH OPENINGS).


- INSPECTION NOTES:

 1. PROVIDE SPECIAL INSPECTION, SPECIAL TESTING, REPORTING AND COMPLIANCE PROCEDURES ACCORDING TO THE LOCAL BUILDING CODE.
- 2. SPECIAL INSPECTOR QUALIFICATIONS: DEMONSTRATE COMPETENCE, TO THE SATISFACTION OF THE BUILDING OFFICIAL, FOR INSPECTION OF THE PARTICULAR TYPE OF CONSTRUCTION OR OPERATION IN QUESTION. PRIOR TO THE BEGINNING OF CONSTRUCTION, REVIEW THE SPECIAL INSPECTION REQUIREMENTS WITH THE ARCHITECT, ENGINEER, BUILDING OFFICIAL, SENERAL CONTRACTOR AND SPECIAL INSPECTORS. DUTIES OF THE SPECIAL INSPECTOR INCLUDE, BUT ARE NOT LIMITED TO:
- 3. OBSERVE THE WORK FOR CONFORMANCE WITH THE APPROVED PERMIT DRAWINGS AND SPECIFICATIONS. BRING DISCREPANCIES TO THE IMMEDIATE ATTENTION OF THE CONTRACTOR FOR BUILDING OFFICIAL.
- 4. FURNISH INSPECTION REPORTS FOR EACH INSPECTION TO THE BUILDING OFFICIAL, ARCHITECT, ENGINEER, GENERAL CONTRACTOR AND OWNER IN A TIMELY
- 5. SUBMIT A FINAL REPORT STATING WHETHER THE WORK REQUIRING SPECIAL INSPECTION WAS INSPECTED, AND WHETHER THE WORK IS IN CONFORMANCE WITH THE APPROVED PERMIT DRAWINGS AND SPECIFICATIONS.

- 2. MAINTAIN ACCESS TO WORK REQUIRING SPECIAL INSPECTION UNTIL IT HAS BEEN OBSERVED AND INDICATED TO BE IN CONFORMANCE BY THE SPECIAL INSPECTOR AND APPROVED BY THE BUILDING OFFICIAL.

DUTIES OF THE CONTRACTOR INCLUDE, BUT ARE NOT LIMITED TO: 1. NOTIFY SPECIAL INSPECTOR THAT WORK IS READY FOR INSPECTION AT LEAST 24 HOURS BEFORE THE INSPECTION IS REQUIRED. +

- 3. PROVIDE THE SPECIAL INSPECTOR WITH ACCESS TO APPROVED PERMIT DRAWINGS AND SPECIFICATIONS AT THE JOB SITE.

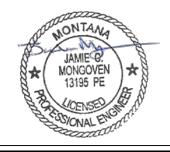

DATE

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BY:

TITLE

LAND EAGLE

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S S S S $\overline{\mathcal{O}}$ Ш


GENERAL NOTES:

THE FOLLOWING NOTES ARE MINIMUM REQUIREMENTS ONLY. CHECK LOCAL BUILDING CODES FOR COMPLIANCE.

- CONTRACTOR SHALL VERIFY ALL CONDITIONS AND DIMENSIONS AT SITE BEFORE BEGINNING CONSTRUCTION. ANY DISCREPANCIES SHALL BE REPORTED TO JM DESIGN CENTER FOR JUSTIFICATION AND/OR REVISIONS BEFORE PROCEEDING WITH YORK. CONTRACTORS SHALL ASSUME RESPONSIBILITY FOR ERRORS THAT ARE NOT REPORTED.
- ALL WOOD, CONCRETE, AND STEEL STRUCTURAL MEMBERS SHALL BE OF A GOOD GRADE AND QUALITY AND MEET ALL NATIONAL, STATE, AND LOCAL BUILDING CODES WHERE APPLICABLE.
- IT IS THE CONTRACTORS RESPONSIBILITY FOR ADJUSTING AND VERIFYING ALL STRUCTURAL DETAILS AND CONDITIONS TO MEET OR EXCEED ALL LOCAL CODES AND INSURE A QUALITY AND SAFE STRUCTURE.
- 4. THESE PLANS ARE NOT FOR RESALE. ANY REPRODUCTION OF THESE PLANS MUST HAVE THE WRITTEN CONSENT OF JM DESIGNS LLC.

| DOOR SCHEDULE | | | | | | | | |
|---------------|---------------|-----|-------|-------------|------------------|--------------------------|--|--|
| NUMBER | LABEL | QTY | FL00R | SIZE | R/O | DESCRIPTION | | |
| D01 | 1068 | 2 | 1 | 1068 EX | 14"X83" | EXT. FIXED-GLASS PANEL | | |
| D02 | 9080 | 2 | 1 | 9080 | 110"X99" | GARAGE-GARAGE DOOR CHD05 | | |
| D03 | 2368 | 1 | 1 | 2368 R | 29 1/16"X82 1/2" | 2 DR. BIFOLD-LOUVERED | | |
| D04 | 2668 | 1 | 1 | 2668 R | 32"X82 1/2" | 2 DR. BIFOLD-LOUVERED | | |
| D05 | 2668 | 2 | 1 | 2668 R IN | 32"X82 1/2" | HINGED-DOOR P04 | | |
| D06 | 2668 | 1 | 1 | 2668 L | 32"X82 1/2" | 2 DR. BIFOLD-LOUVERED | | |
| D07 | 2668 | 1 | 1 | 2668 L IN | 32"X82 1/2" | HINGED-DOOR P04 | | |
| D08 | 28 6 8 | 1 | 1 | 2868 R IN | 34"X82 1/2" | HINGED-DOOR P04 | | |
| D09 | 28 6 8 | 4 | 1 | 2868 L IN | 34"X82 1/2" | HINGED-DOOR P04 | | |
| D10 | 3068 | 1 | 1 | 3068 R EX | 38"X83" | EXT. HINGED-DOOR E19 | | |
| D11 | 3068 | 1 | 1 | 3068 L EX | 38"X83" | EXT. HINGED-DOOR E01 | | |
| D12 | 3068 | 1 | 1 | 3068 L IN | 38"X82 1/2" | HINGED-DOOR P04 | | |
| D13 | 5 068 | 1 | 1 | 5068 L/R IN | 62"X82 1/2" | DOUBLE HINGED-DOOR P04 | | |
| D14 | 6068 | 1 | 1 | 6068 R EX | 74"X83" | EXT. SLIDER-GLASS PANEL | | |
| D15 | 3068 | 1 | 1 | 3068 R EX | 38"X83" | EXT. HINGED-DOOR E21 | | |

| MINDOM SCHEDULE | | | | | | | | | | |
|-----------------|--------|-----|-------|--------|-----------------|--------|--------------|--|--|--|
| NUMBER | LABEL | QTY | FLOOR | SIZE | R/O | EGRESS | DESCRIPTION | | | |
| | 4040LS | 2 | | | 49"X49" | | LEFT SLIDING | | | |
| M02 | 4040LS | 1 | | | 49"X49" | YES | LEFT SLIDING | | | |
| M03 | 6040LS | 1 | | | 7 3"X49" | | LEFT SLIDING | | | |
| M04 | 6040LS | 2 | | | 73"X49" | YES | LEFT SLIDING | | | |
| M05 | 1616FX | 1 | 2 | 1616FX | 19"X19" | | FIXED GLASS | | | |

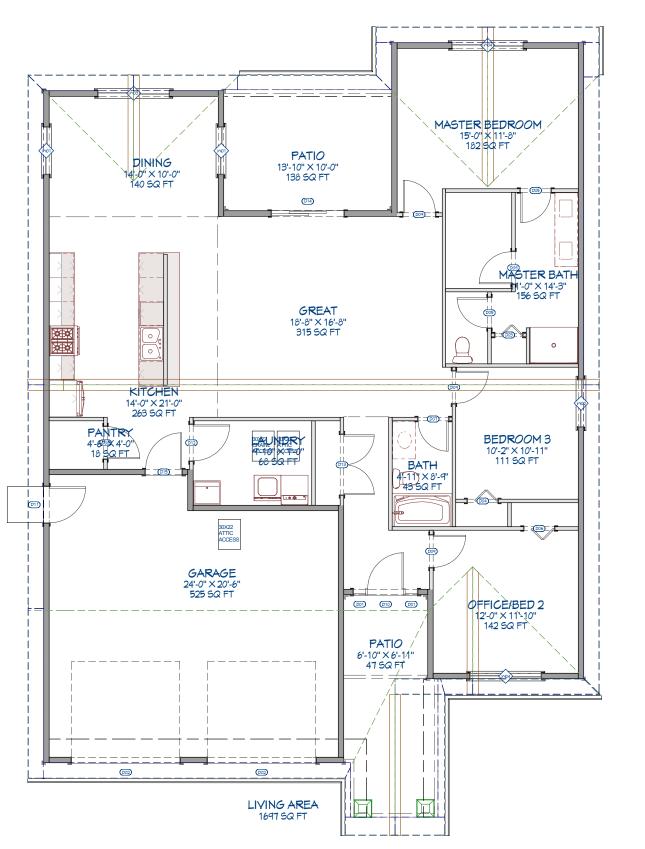



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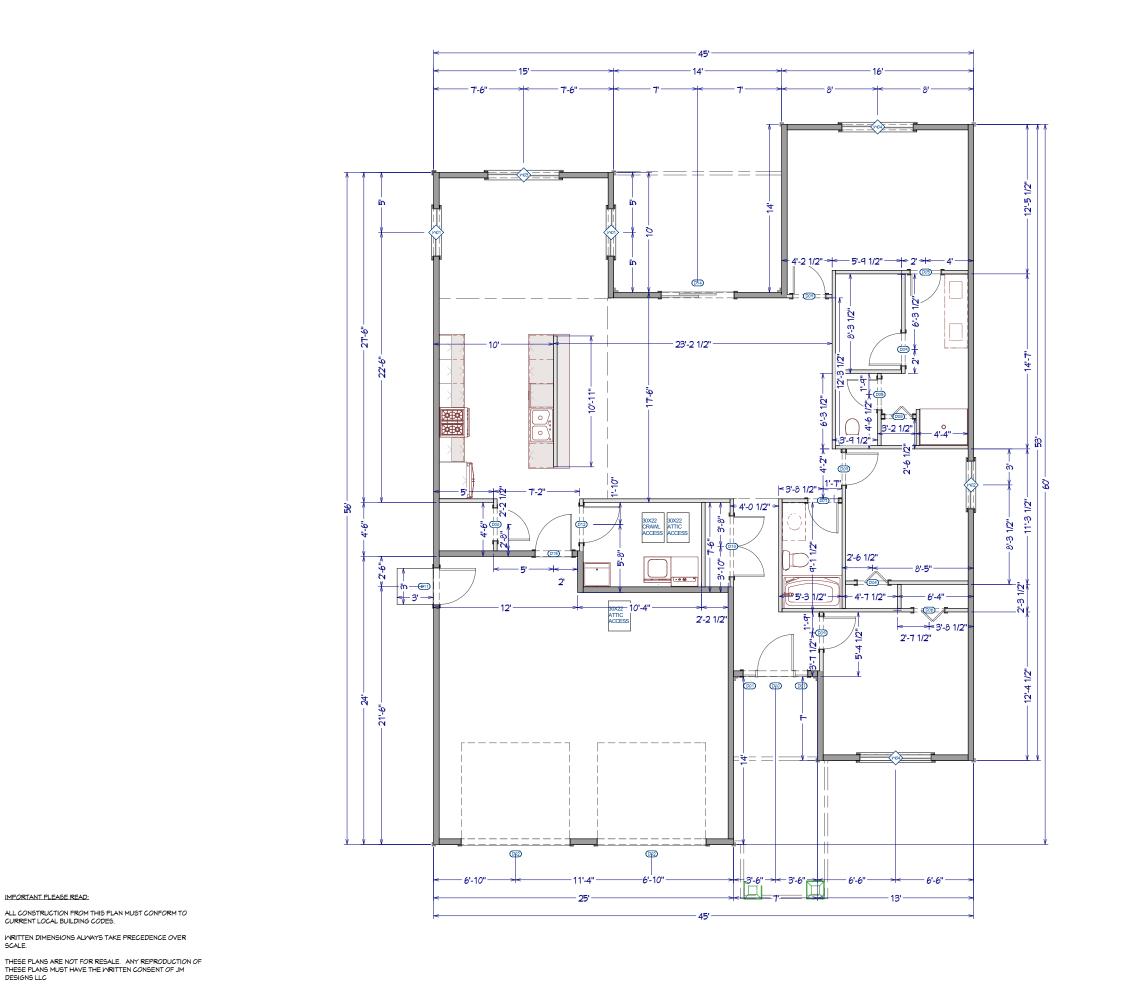
ÌI LAYOUT **SCALE: 1/8"**

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EAGLE LAND INC.

CONSTRUCTION

SCALE: 1/8"

SHEET NUMBER

P F 3

DRAWN BY: JCM DATE: 10/1/2023

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DESIGNS LLC

MONTANA

JAMIE C. MONGOVEN 13195 PE

- FLOOR PLAN NOTES:

 1. ALL EXTERIOR DIMENSIONS ARE TO THE MAIN LAYER DIMENSIONS TO OPENINGS ARE TO THE FRAMING, CENTER OF THE ROUGH OPENING. INTERIOR DIMENSIONS ARE TO THE FINISHED WALL.
- CONTRACTOR SHALL VERIFY ALL DIMENSIONS AND IS
 RESPONSIBLE FOR ALL DIMENSIONS (INCLUDING ROUGH

- INSPECTION NOTES:

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- LIMIED TO:

 3. OBSERVE THE WORK FOR CONFORMANCE WITH THE
 APPROVED PERMIT DRAWINGS AND SPECIFICATIONS.
 BRING DISCREPANCIES TO THE IMMEDIATE ATTENTION
- OF THE CONTRACTOR FOR BUILDING OFFICIAL.

 4. FURNISH INSPECTION REPORTS FOR EACH INSPECTION TO THE BUILDING OFFICIAL, ARCHITECT, ENGINEER, GENERAL CONTRACTOR AND OWNER IN A TIMELY MANNER
 5. SUBMIT A FINAL REPORT STATING WHETHER THE WORK
- REQUIRING SPECIAL INSPECTION WAS INSPECTED, AND WHETHER THE WORK IS IN CONFORMANCE WITH THE APPROVED PERMIT DRAWINGS AND SPECIFICATIONS.


- DUTIES OF THE CONTRACTOR INCLUDE, BUT ARE NOT LIMITED TO:

 1. NOTIFY SPECIAL INSPECTOR THAT WORK IS READY FOR INSPECTION AT LEAST 24 HOURS BEFORE THE INSPECTION IS REQUIRED.

 2. MAINTAIN ACCESS TO WORK REQUIRING SPECIAL INSPECTION INTO THE DAY OF THE DA
- INSPECTION UNTIL IT HAS BEEN OBSERVED AND INDICATED TO BE IN CONFORMANCE BY THE SPECIAL INSPECTOR AND APPROVED BY THE BUILDING OFFICIAL.

 3. PROVIDE THE SPECIAL INSPECTOR WITH ACCESS TO
- APPROVED PERMIT DRAWINGS AND SPECIFICATIONS AT THE JOB SITE.

 4. MAINTAIN JOB-SITE COPIES OF ALL REPORTS
- SUBMITTED BY THE SPECIAL INSPECTOR.

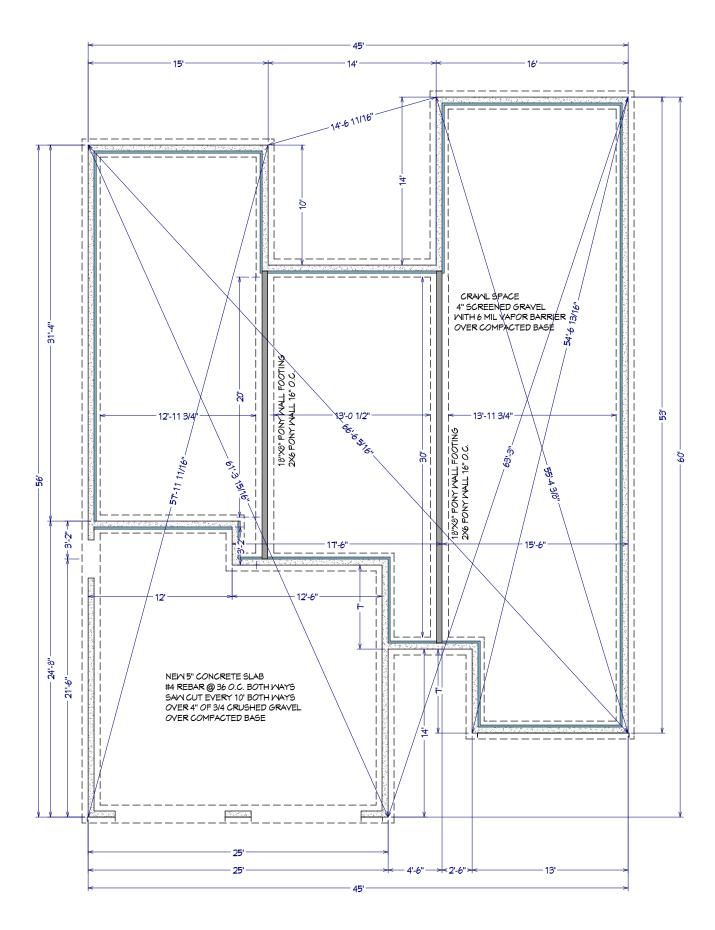

SHEET NUMBER Р 4 DATE: 10/1/2023

LAYOUT FOUNDATION SCALE

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JAMIE 6.

MONGOVEN 13195 PE

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ROOF INFORMATION: ROOF PITCH OVERHANG = 6:12 and 8:12 = 16" = 16" GABLE OVERHANG

> GABLE GABLE RIDGE PITCH CHANGE 3:12 SHED ROOF GABLE



ALL CONSTRUCTION FROM THIS PLAN MUST CONFORM TO CURRENT LOCAL BUILDING CODES.

WRITTEN DIMENSIONS ALWAYS TAKE PRECEDENCE OVER SCALE.

THESE PLANS ARE NOT FOR RESALE. ANY REPRODUCTION OF THESE PLANS MUST HAVE THE WRITTEN CONSENT OF JM DESIGNS LLC

MONTANA JAMIE 6: MONGOVEN 13195 PE

<u>_</u> PO 2

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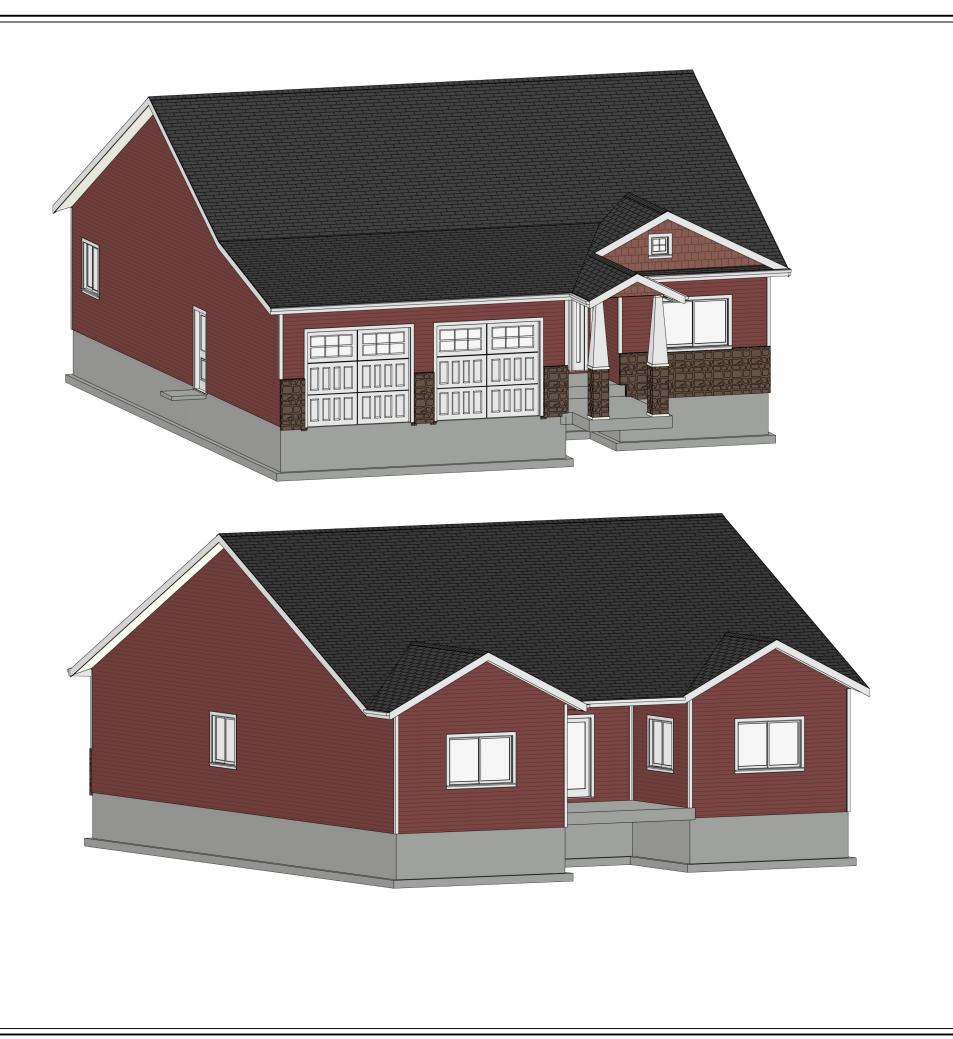
SCALE: 1/8" = 1' ROOF PLAN

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DESIGNS LLC



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<u>_</u> PO

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ORTHO VIEW

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MONTANA

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FRONT ELEVATION



REAR ELEVATION

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MONTANA JAMIE C. MONGOVEN 13195 PE ELEVATIONS SCALE: 1/8"

SHEET NUMBER

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DRAWN BY: JCM DATE: 10/1/2023


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DESIGNS



LEFT ELEVATION



RIGHT ELEVATION

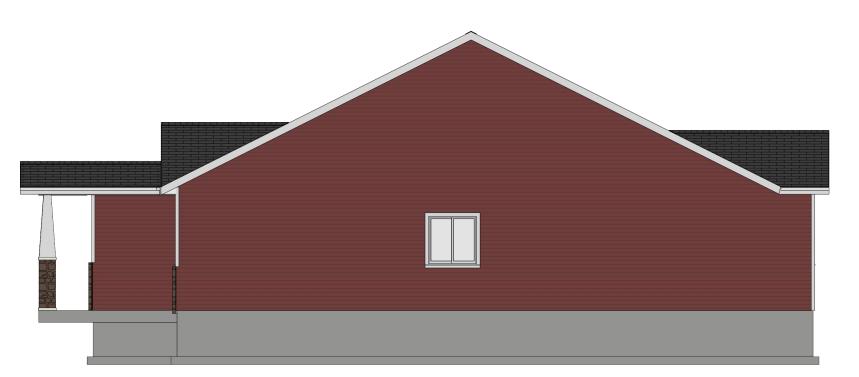IMPORTANT PLEASE READ:

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MONTANA JAMIE C. MONGOVEN 13195 PE

DATE: 10/1/2023 DRAWN BY: JCM **ELEVATIONS**

8 11 ₽

SHEET NUMBER

SCALE: 1/8"


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DESIGNS LLC

FRAMING NOTES:

- 1. THE FOLLOWING NOTES ARE MINIMUM REQUIREMENTS ONLY. CHECK LOCAL BUILDING CODES FOR COMPLIANCE
- 2. PROVIDE FIRE BLOCKING IN ALL WALLS 10'-0" IN HEIGHT OR OVER. BLOCK ALL SEAMS IN SHEATHING.
- 3. ALL JOINTS IN RAFTERS SHALL BE ALIGNED OVER STUDS BELOW.
- 4. ALL EXTERIOR BEARING WALL HEADERS LESS THAN 66" IN LENGTH SHALL BE 2-2"X10" WITH 2"X6" FLITCH PLATE UNLESS OTHERWISE NOTED. INTERIOR HEADERS SHALL BE 2 2"X6" WITH 2"X4" FLITCH PLATE UNLESS OTHERWISE NOTED.
- 5. FRAMING TO INSTALL DOUBLE FLOOR JOISTS UNDER PARTITION WALLS PARALLEL TO JOIST DIRECTION.
- 6. ALL COLUMNS OR SOLID FRAMING SHALL EXTEND DOWN THRU ALL LEVELS AND TERMINATE AT THE BASEMENT FLOOR AND BE SUPPORTED BY THICKED SLAB, GRADE BEAM OR FOOTING DESIGNED TO CARRY LOAD.
- 7. ROOF SHEATHING SHALL BE 7/16" O.S.B. MIN.
- 8. PROVIDE COLLAR TIES @ UPPER 1/3 OF VERTICAL DISTANCE BETWEEN RIDGE BOARD AND CEILING JOISTS@ 4'-0" O.C. MAX.
- 9. ALL CEILING JOISTS AND RAFTER BRACING TO BEAR ON LOAD BEARING WALLS DESIGNED TO CARRY LEAD THRU ALL LEVELS AND TERMINATE AT THE LOWEST FLOOR AND BE SUPPORTED BY THICKED SLAB, GRADE BEAM OR FOOTING DESIGNED TO CARRY
- 10. ALL SOLID FRAMING, COLUMNS AND BEAMS TO MEET 2018 IRC AND LOCAL CODES.
- 11. WHERE PRE-ENGINEERED ROOF TRUSSES ARE USED TRUSS MANUFACTURER MUST PROVIDE SHOP DRAWINGS WHICH BEAR THE SEAL OF REGISTERED ENGINEER IN STATE WHERE WORK IS BEING PERFORMED.
- 12. METAL ROOF MANUFACTURER'S INSTALLATION INSTRUCTIONS SHALL BE ON SITE FOR INSPECTION.



TYPICAL WALL SECTION WITH CRAWL SPACE

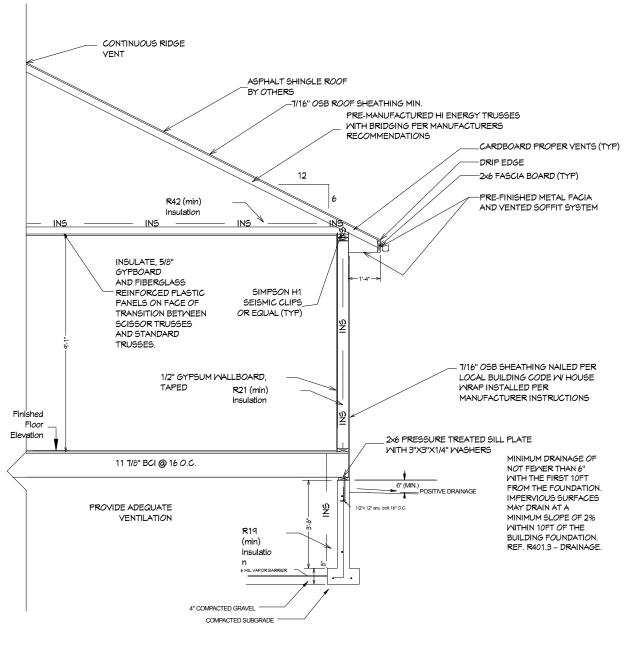IMPORTANT PLEASE READ:

ALL CONSTRUCTION FROM THIS PLAN MUST CONFORM TO CURRENT LOCAL BUILDING CODES.

WRITTEN DIMENSIONS ALWAYS TAKE PRECEDENCE OVER

THESE PLANS ARE NOT FOR RESALE. ANY REPRODUCTION OF THESE PLANS MUST HAVE THE WRITTEN CONSENT OF JM DESIGNS LLC

MONTANA JAMIE C. MONGOVEN SHEET NUMBER Р 0

DATE: 10/1/2023

SECTION 1/4" SCALE: TYPICAL

EAGLE LAND INC

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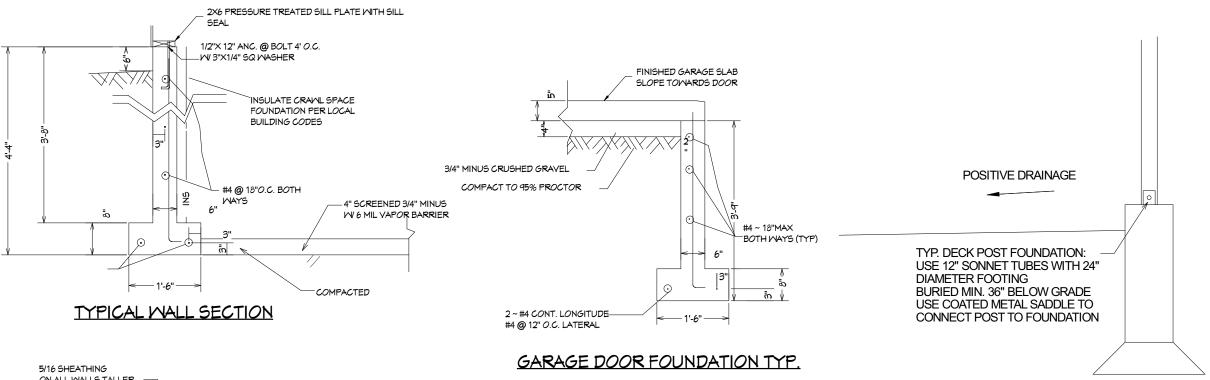
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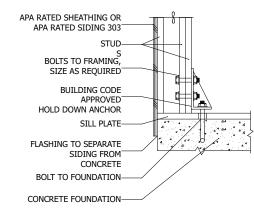
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ON ALL WALLS TALLER THAN 4' 2X6 PRESSURE TREATED W SILL SEAL 1/2"X 6" ANC. BOLT 24" O.C. 2~#4 CONT. LONGITUDE #4 @ 12" SPACING -2 LATERAL 3/4" MINUS SCREENED GRAVEL

PONY WALL FOOTING

SHEAR WALL FOUNDATION ANCHOR HIGH SHEAR WALL OVERTURNING MOMENTS MAY BE TRANSFERRED BY A FABRICATED STEEL BRACKET SUCH AS THIS. REGULAR FOUNDATION BOLTS MAY BE ALL THAT IS REQUIRED IN SOME CASES.




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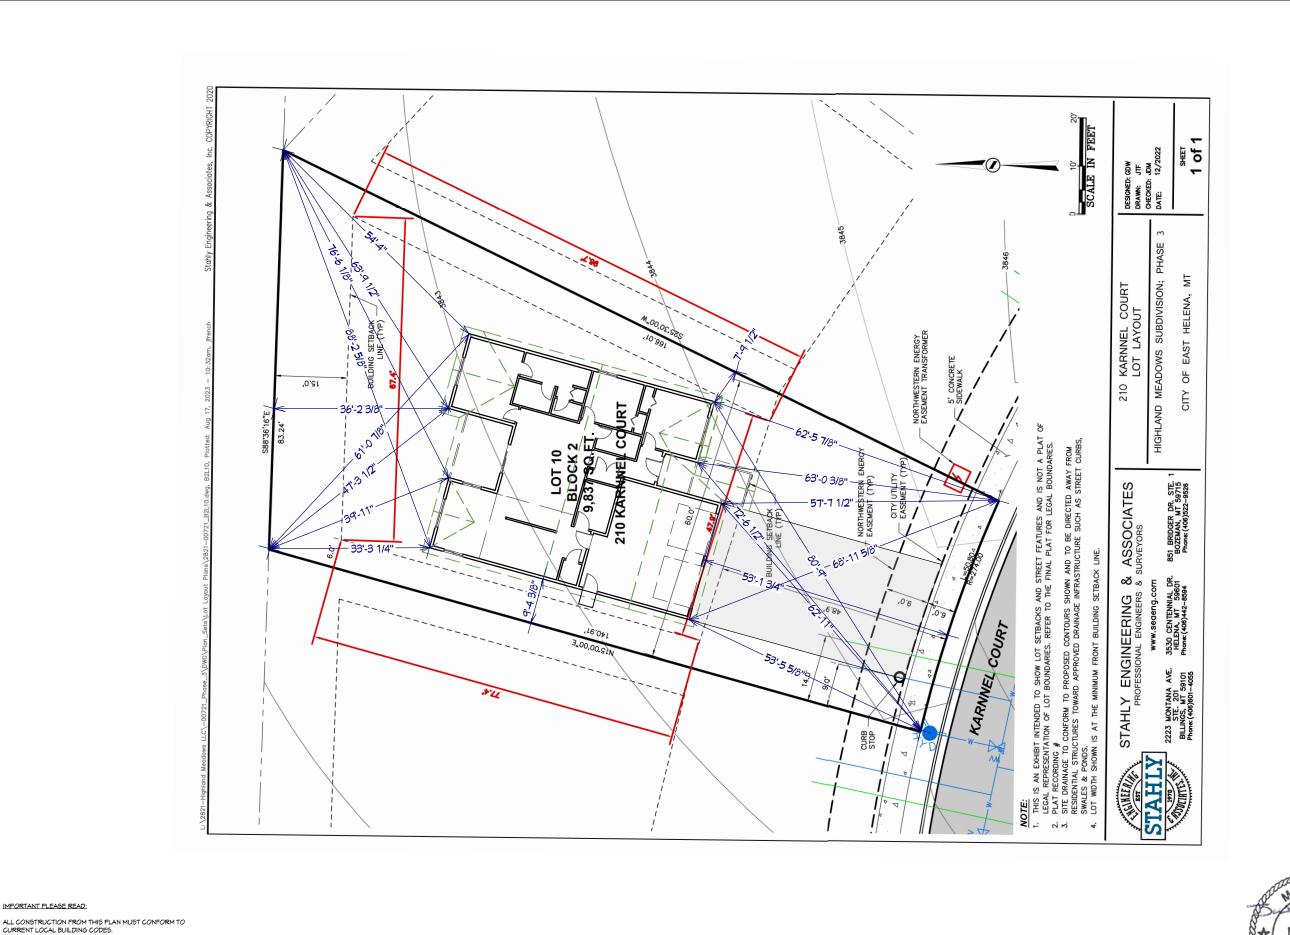
HOLD DOWN INSTALLATION TYP.



GARAGE FOUNDATION TYP.

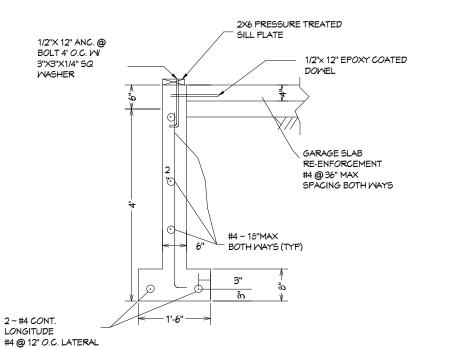

TYPICAL POST FOUNDATION



IMPORTANT PLEASE READ:

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BALD EAGLE LAND INC.

SHEET NUMBER

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DRAWN BY: JCM DATE: 10/1/2023

SCALE: 1' = 200'

SITE PLAN